

RENDER NOT INCLUDED IN QUOTE.







ROJECT.		DRAWING TITLE.		
PROPOSED RESIDENCE FOR *. & *. *****		RENDER – NOT INCLUDED IN PRICE		
LOT ****, ****** QLD	***			
ESIGNED BY. DP	DRAWN BY. DP	DRAWING SCALE.	DRAWING NUMBER.	ISSUE.
^{ATE.} JANUARY 2016	PROJECT No. ****	@ A3	A000	Α

PROPOSED RESIDENCE

REAL PROPERTY DESCRIPTION

LOT ***, R.P. *****
PARISH: WOOLGOOLGA
COUNTY: FITZROY
AREA: 768m²





3D PERSPECTIVE 1



3D PERSPECTIVE 2

SCALE @ A3




QBSA: 1122353 ABN: 93158362031





PROJECT.		DRAWING TITLE.		
PROPOSED RESIDENCE FOR	*. & *. ****	TITLE SHEET		
LOT ****, ****** QLD	***			
DESIGNED BY. DP	DRAWN BY. DP	DRAWING SCALE.	DRAWING NUMBER.	ISSUE.
^{DATE.} JANUARY 2016	PROJECT No. ****	@ A3	A001	Α

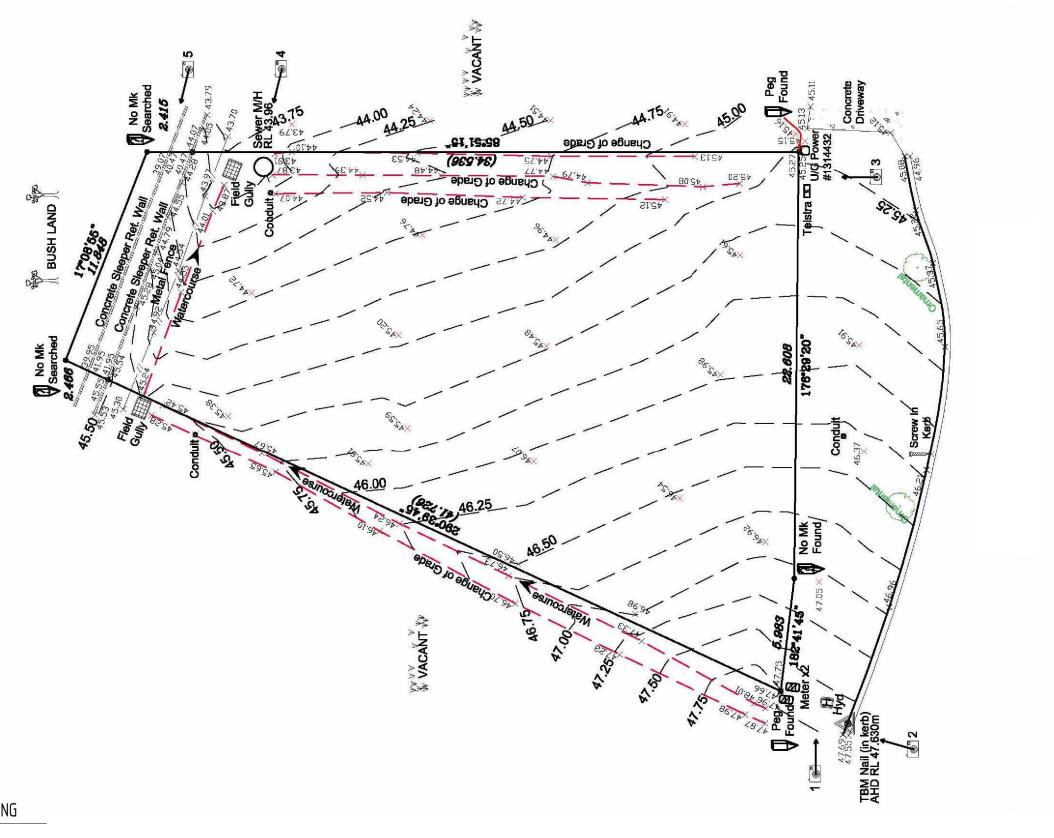


SITE PLAN - EXISTING

SCALE 1: 200 @ A3



NORTH

	PROJECT. PROPOSED RESIDENCE FOR		DRAWING TITLE. SITE PLAN - EXISTING	-	
Λ H Ω Λ	LOT ****, ****** QLD ***		SITE LEAN - EXISTING		
ARCHITECTURAL HOUSE DESIGNS AUSTRALIA	DESIGNED BY. DP	DRAWN BY. DP	DRAWING SCALE.	DRAWING NUMBER.	ISSUE.
	^{DATE.} JANUARY 2016	PROJECT No. ****	1:200 @ A3	A101	Α

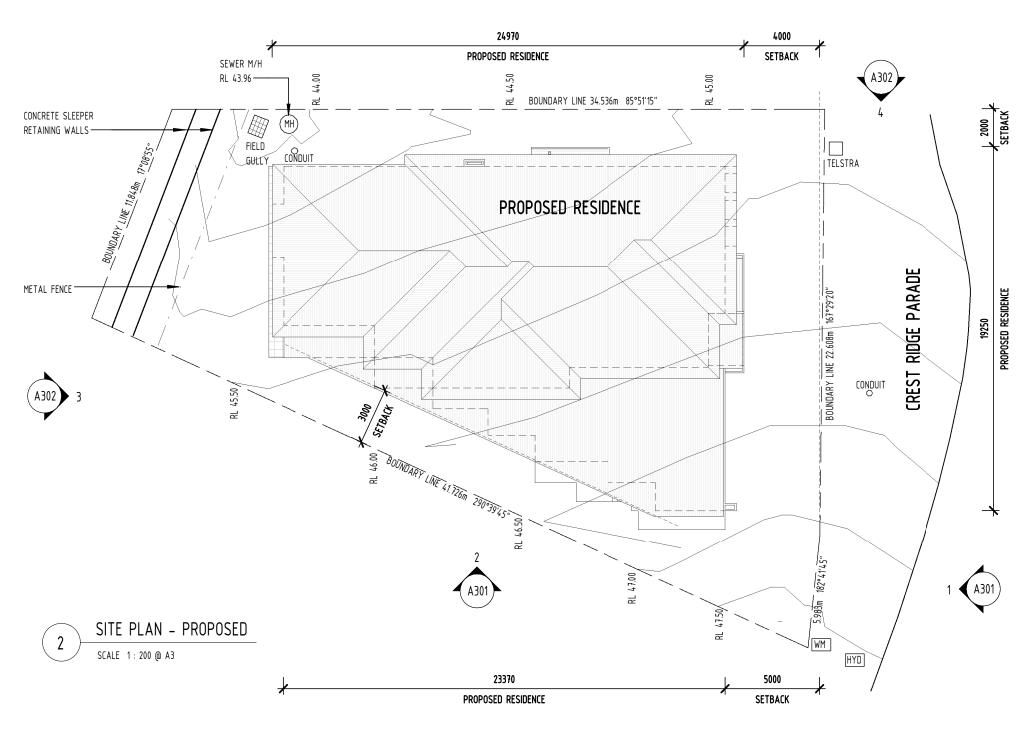

DESIGNED IN ACCORDANCE WITH BCA

- STAIRS TO COMPLY WITH PART 3.9.1 & 3.9.2
- BALUSTRADES TO COMPLY WITH PART 3.9.2
- TERMITE PROTECTION TO COMPLY WITH AS3660.1
- WC DOORS TO COMPLY WITH PART 3.8.3.3
- ALL WET AREAS TO COMPLY WITH 3.8.1
- LIGHTING TO COMPLY WITH 3.8.4
- VENTILATION TO COMPLY WITH 3.8.5
- AUTO SMOKE DETECTION & ALARM SYSTEM 3.7.2
- FLASHING TO WALL OPENINGS 3.5.3.6
- GLAZING & WINDOW ASSEMBLIES 3.6.0
- HOT WATER SUPPLY SYSTEM 3.12.5
- ENERGY EFFICIENCY TO COMPLY WITH 3.12 (2011)

NOTES

- ALL DIMENSIONS TO BE CONFIRMED ON SITE PRIOR TO COMMENCEMENT OF
- REFER STRUCTURAL ENGINEER'S DRAWINGS FOR DETAILS OF ALL REINFORCED CONC. SLABS, FLOOR FRAMING, POSTS, FOOTINGS, RETAINING WALLS, TIMBER FRAMING, TIE-DOWN & BRACING
- DOWNPIPES TO CONNECT TO STORMWATER LINE OR RAINWATER TANKS
- ALL EXTERNAL STEEL WORK INCLUDING FIXINGS TO BE HOT DIPPED GALVANISED
- OWNERS TO SELECT FINISHES, FIXTURES & LIGHTING
- WHILE GREAT CARE HAS BEEN TAKEN TO BE AS ACCURATE AS POSSIBLE, BUILDER
- IS TO CONFIRM DIMENSIONS ON SITE BEFORE CONSTRUCTION
- BUILDER TO CONFIRM SIZES ON SITE BEFORE ORDERING DOORS & WINDOWS

AREA LEGEND

GROUND FLOOR $= 246.6 \text{m}^2$ $= 202.6 \text{m}^2$ FIRST FLOOR $= 51.8 \text{m}^2$ **ALFRESCO** $= 5.2 \text{m}^2$ PORCH GARAGE $= 44.3 \text{m}^2$

TOTAL $= 550.5 \text{m}^2$

MAX SITE COVERAGE = $384m^2$ (50%) SITE COVERAGE ACHIEVED = 373.4m² (48.6%)

REAL PROPERTY DESCRIPTION

LOT ***, R.P. **** PARISH: WOOLGOOLGA COUNTY: FITZROY

AREA: 768m²

FLOOR PLAN LEGEND

ВА BATH ВС BROOM CUPBOARD

BE **BENCH** CK COOKTOP CPD CUPBOARD

DP 100mm DIA COLORBOND DOWNPIPE. CONNECT TO RAINWATER TANK OR

EXISTING STORMWATER LINE DW DISHWASHER

FP FIRE PLACE

FLOOR WASTE HOSE COCK

HC LINEN CUPBOARD

MW MICROWAVE OVEN

MI WALL MIRROR OHC OVER HEAD CUPBOARD

PTY PANTRY

REF REFRIGERATOR - TO HAVE TAP

FOR PLUMBING RH

SC ALUMINIUM SCREEN TO CLIENTS SELECTION

SH SHELVES (SHx1 = 1 SHELF)

SHR SHOWER SK SINK

LAUNDRY TUB

TR TOWEL RAIL

TRH TOILET ROLL HOLDER

VANITY BASIN

WATER CLOSET WALK IN PANTRY

WASHING MACHINE LOCATION

NO STEP DOWN IN FLOOR LEVEL. STRUCTURAL SET-DOWN TO ALL INTERNAL

TILED WET AREAS TO ALLOW FOR LEVEL TRANSITION. REFER TO ENGINEERS DETAILS

ST DN STEP DOWN IN FLOOR LEVEL

DOOR NUMBER, REFER TO SCHEDULE

WINDOW NUMBER, REFER TO SCHEDULE

WALL LEGEND

90mm TIMBER STUD WALL WITH FC SHEETING TO EXTERIOR, RENDERED FINISH. PLASTERBOARD TO INTERIOR PAINT FINISH. AQUACHEK TO WET AREAS. R2.8 WALL INSULATION

90mm TIMBER STUD WALL WITH WEATHERBOARDS TO EXTERIOR, PAINT FINISH. PLASTERBOARD TO INTERIOR, PAINT FINISH. AQUACHEK TO WET AREAS, R2.8 WALL INSULATION

70mm TIMBER STUD WALL WITH FC SHEETING WITH EXPOSED BATTENS TO EXTERIOR, PAINT FINISH. PLASTERBOARD TO INTERIOR, PAINT FINISH. AQUACHEK

TO WET AREAS. R2.8 WALL INSULATION

WL4 90mm TIMBER STUD WALL WITH MATRIX CLADDING TO EXTERIOR, PAINT FINISH. PLASTERBOARD TO INTERIOR, PAINT FINISH. AQUACHEK TO WET

90mm TIMBER STUD WALL WITH PLASTER BOARD TO INTERIOR, PAINT

FINISH . AQUACHEK TO WET AREAS

AREAS. R2.8 WALL INSULATION

190mm CORE FILLED BLOCKWORK RETAINING WALL AND FOOTING TO ENGINEERS SPECIFICATIONS

FLOOR FINISH LEGEND

CON CONCRETE - BROOM FINISH СРТ CARPET

СТ CERAMIC TILES

VITRIFIED TILES - NON SLIP



MB: 0423 303 011


QBSA: 1122353 ABN: 93158362031





ALL DIMENSIONS TO BE CONFIRMED ON SITE BEFORE ORDERING OR PREFABRICATING WORKS. CLARIFY ANY DISCREPANCIES BEFORE PROCEEDING. DO NOT SCALE FROM DRAWINGS. THESE DESIGNS AND PLANS ARE SUBJECT TO THE COPYRIGHT ACT OF 1968 AND THE COPYRIGHT AMENDMENT (MORAL RIGHTS) BILL 1999 AND ARE NOT TO BE USED OR REPRODUCED WITHOUT THE WRITTEN CONSENT OF THE PROPRIETOR.



PROJECT DRAWING TITLE. PROPOSED RESIDENCE FOR *. & *. ***** SITE PLAN - PROPOSED / LEGENDS LOT **** ****** QLD *** DESIGNED BY. DRAWING SCALE. DRAWING NUMBER. ISSUE. DRAWN BY. ΠP PF Α DATE. JANUARY 2016 PROJECT No. **** As indicated @ A3 A102

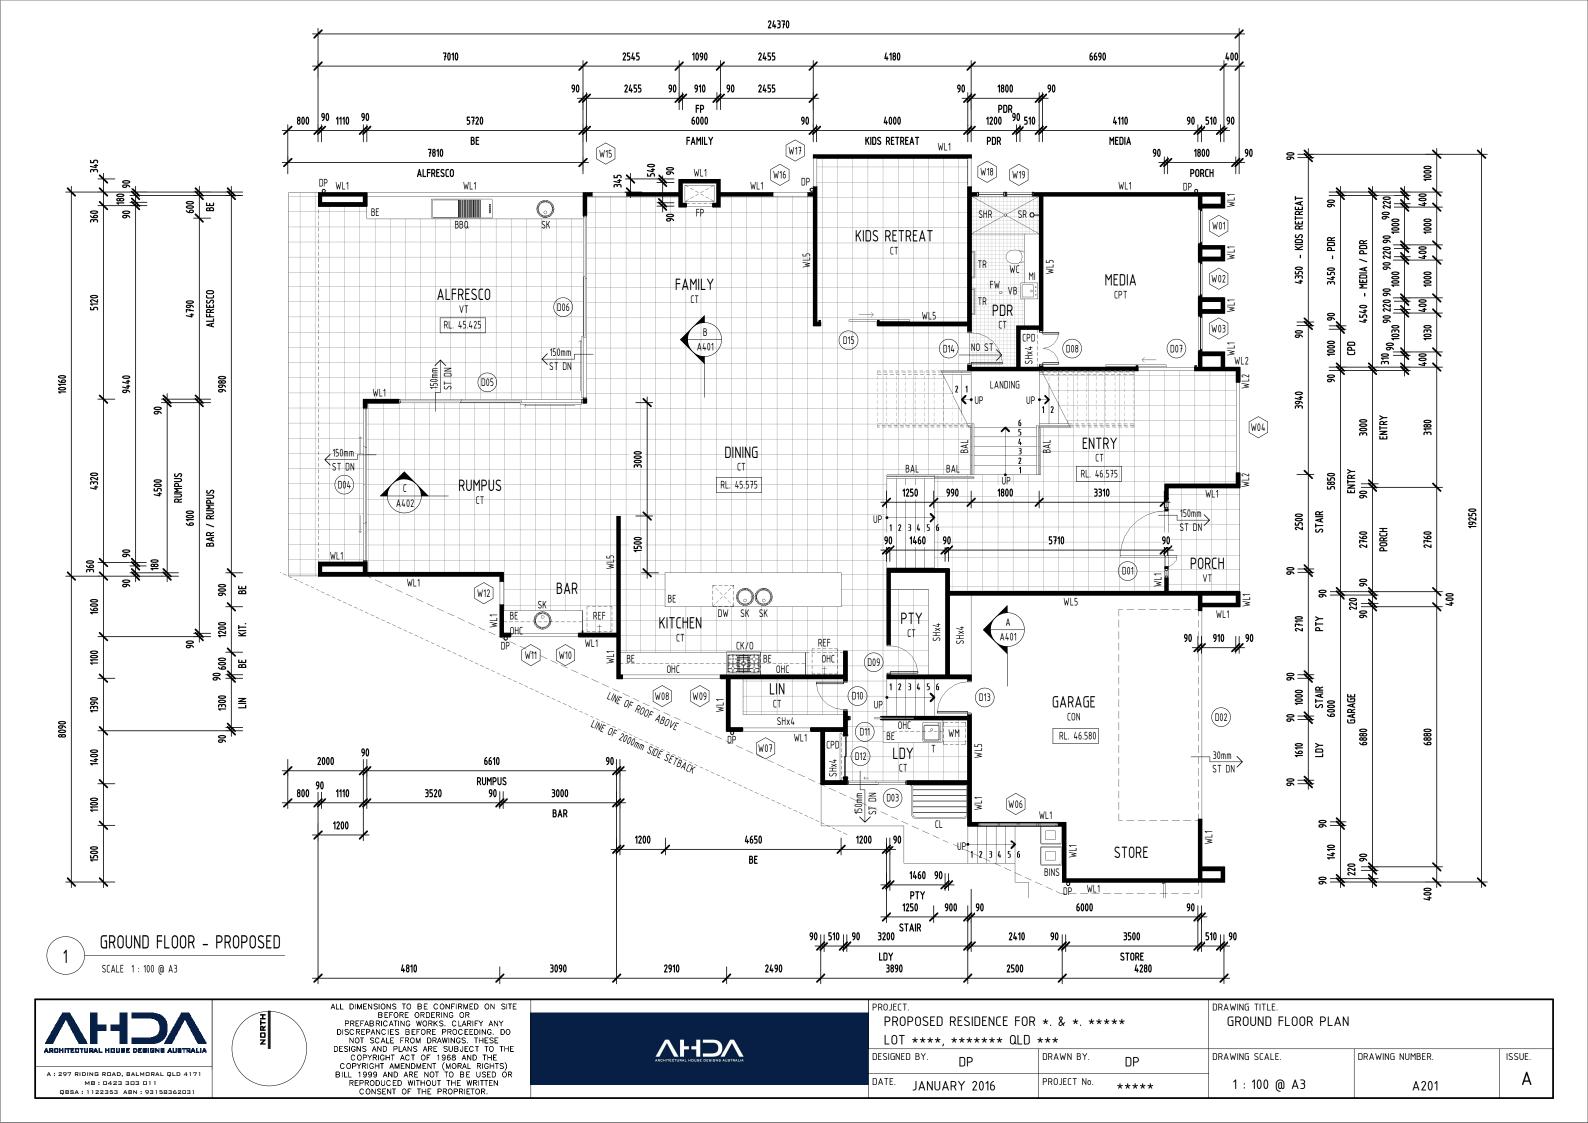

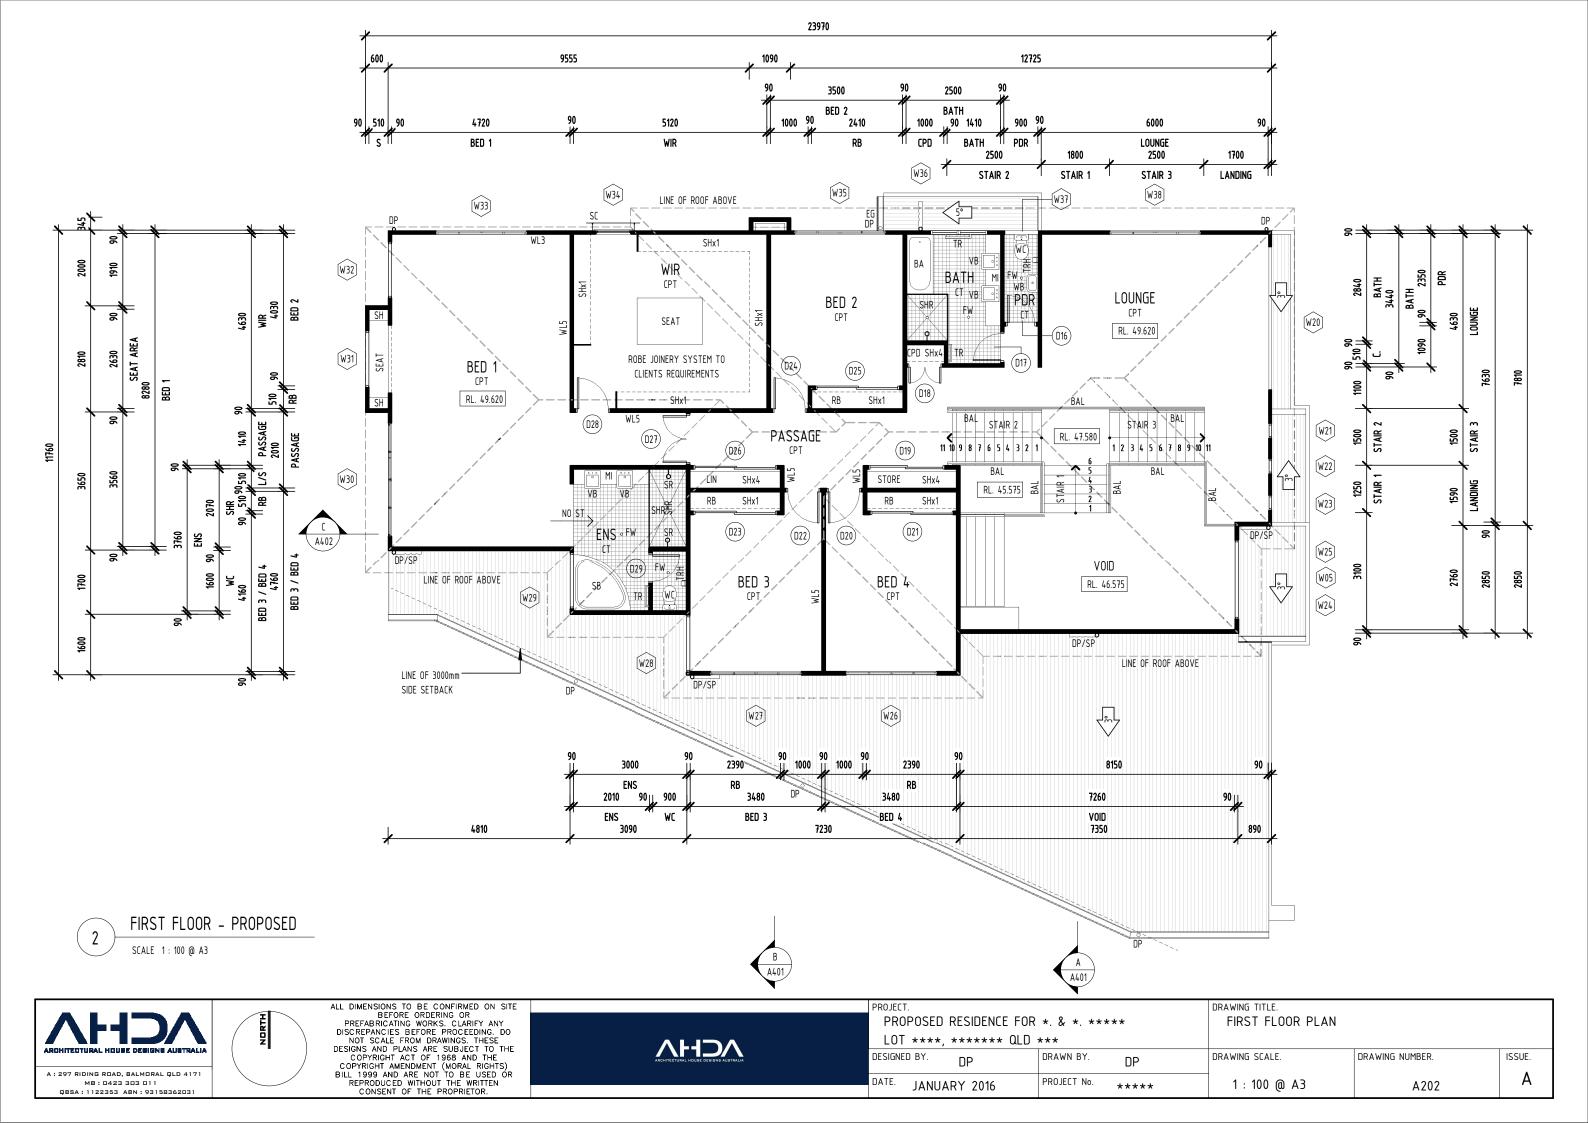

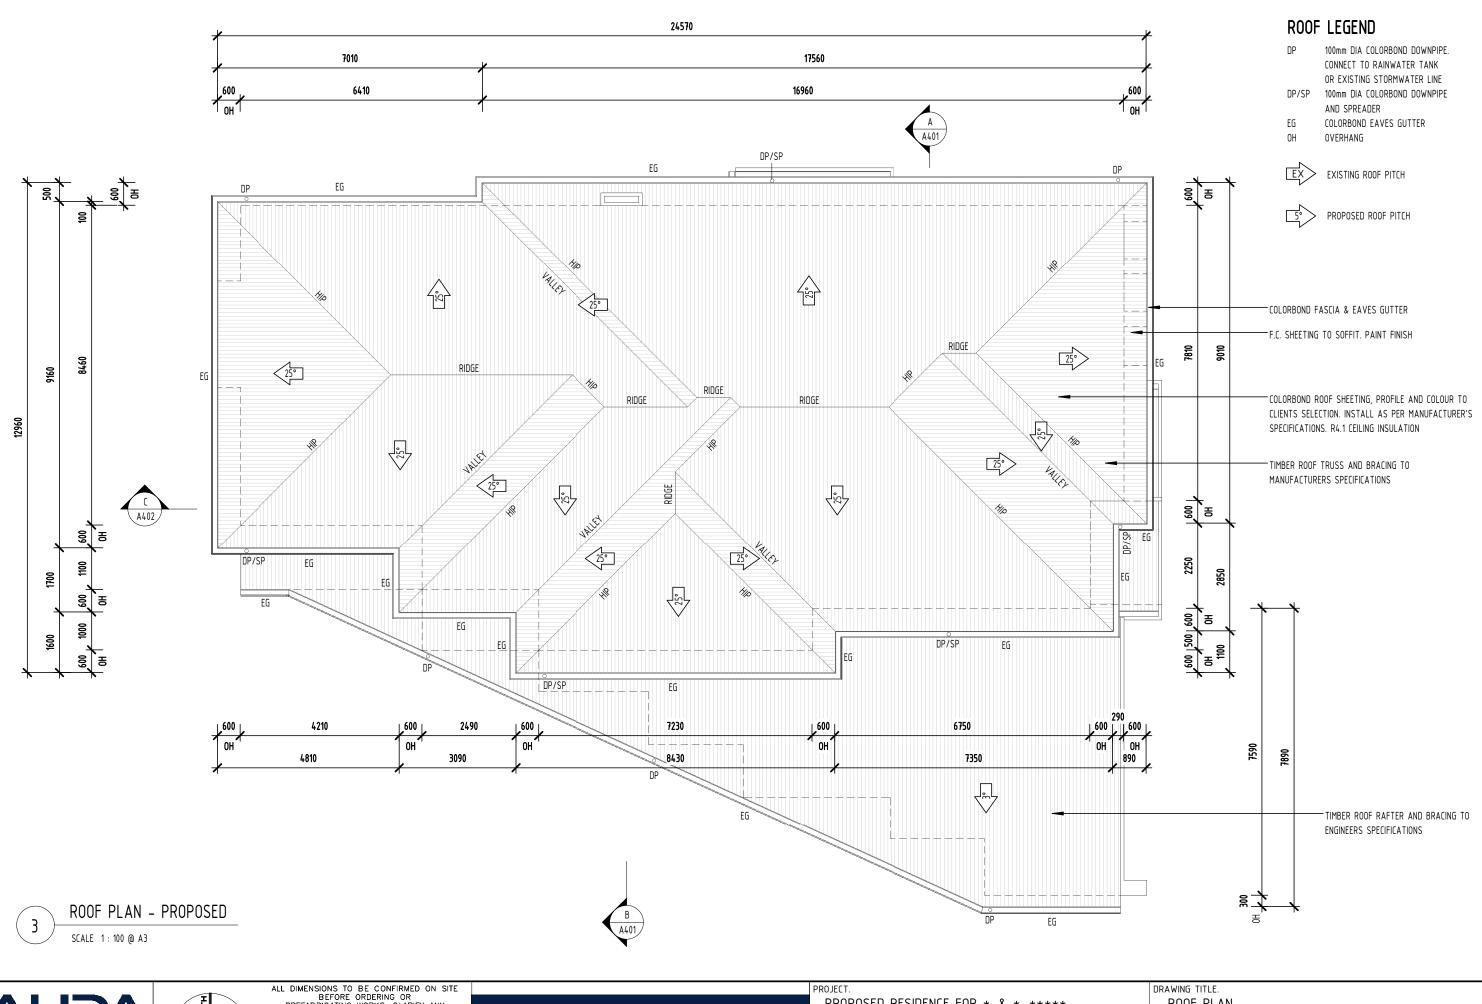




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NORTH

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DESI

ROJECT. PROPOSED RESIDENCE FOR	*. & *. ****	DRAWING TITLE. ROOF PLAN		
LOT ****, ****** QLD :	***			
SIGNED BY. DP	DRAWN BY. DP	DRAWING SCALE.	DRAWING NUMBER.	ISSUE.
ATE. JANUARY 2016	PROJECT No. ****	1:100 @ A3	A203	Α



FLOOR FINISH LEGEND

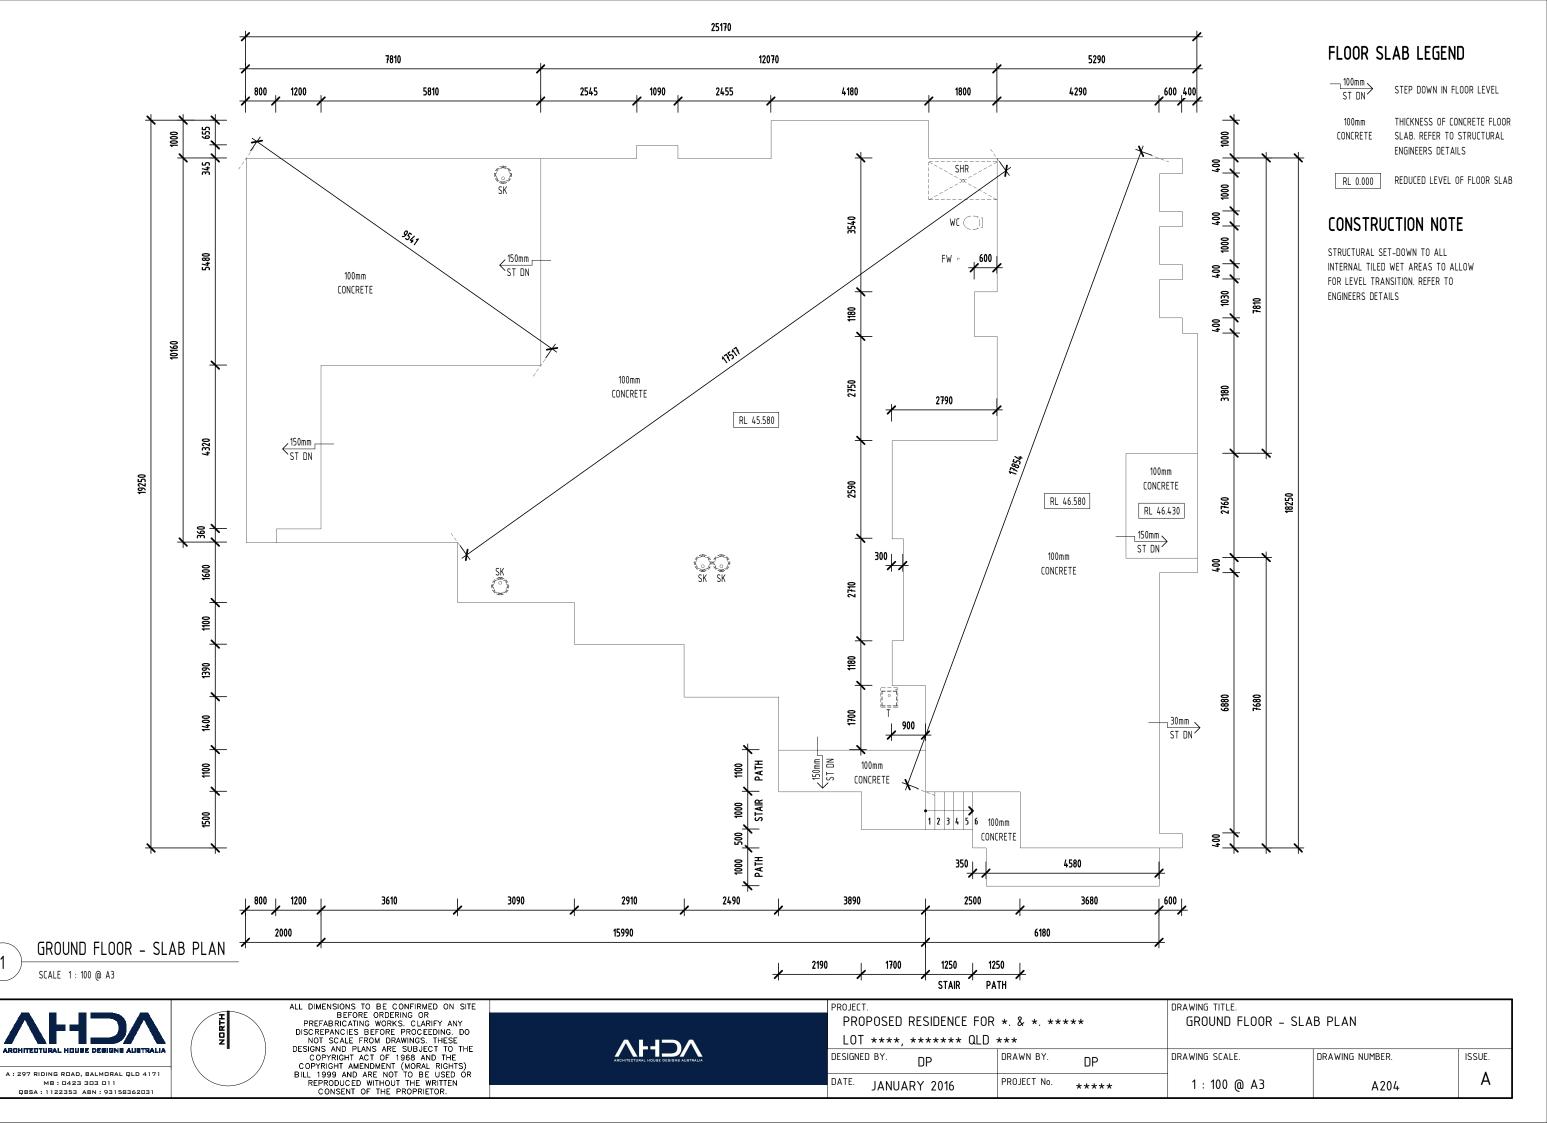CON CONCRETE - BROOM FINISH


CPT CARPET

CT CERAMIC TILES

VT VITRIFIED TILES - NON SLIP

ISSUE.

Α

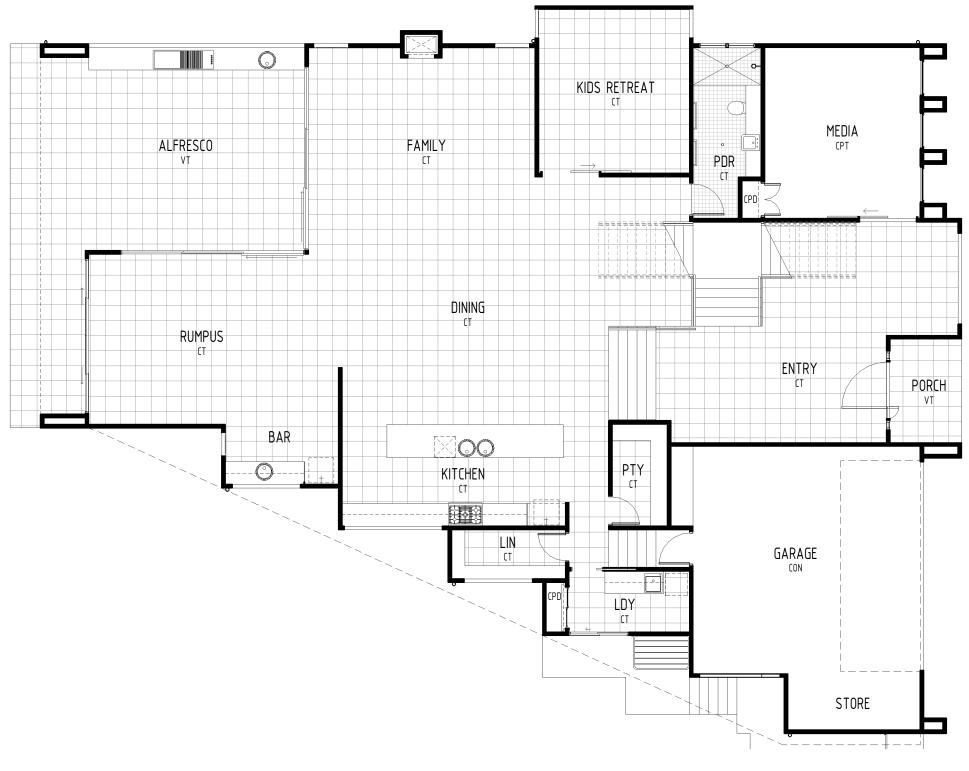

GROUND FLOOR - FLOOR FINISHES

SCALE 1: 100 @ A3





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PROJECT.		DRAWING TITLE.		
PROPOSED RESIDENCE FOR	*. & *. ****	GROUND FLOOR - FLO	OR FINISHES	
LOT ****, ****** QLD *	***			
DESIGNED BY. DP	DRAWN BY. DP	DRAWING SCALE.	DRAWING NUMBER.	
DATE. JANUARY 2016	PROJECT No. ****	1 : 100 @ A3	A206	

FLOOR FINISH LEGEND

CON CONCRETE - BROOM FINISH

CPT CARPET CT CERAMIC TILES

VITRIFIED TILES - NON SLIP



FIRST FLOOR - FLOOR FINISHES SCALE 1:100 @ A3






ALL DIMENSIONS TO BE CONFIRMED ON SITE BEFORE ORDERING OR PREFABRICATING WORKS. CLARIFY ANY DISCREPANCIES BEFORE PROCEEDING. DO NOT SCALE FROM DRAWINGS. THESE DESIGNS AND PLANS ARE SUBJECT TO THE COPYRIGHT ACT OF 1968 AND THE COPYRIGHT AMENDMENT (MORAL RIGHTS) BILL 1999 AND ARE NOT TO BE USED OR REPRODUCED WITHOUT THE WRITTEN CONSENT OF THE PROPRIETOR.

PROJECT.	
PROPOSED RESIDENCE FOR	*. & *. ****
LOT ****, ****** QLD	***
DESIGNED BY. DP	DRAWN BY. DP

JANUARY 2016

PROJECT No.

DRAWING SCALE.	DRAWING NUMBER.	ISSUE.
1:100 @ A3	A207	Α

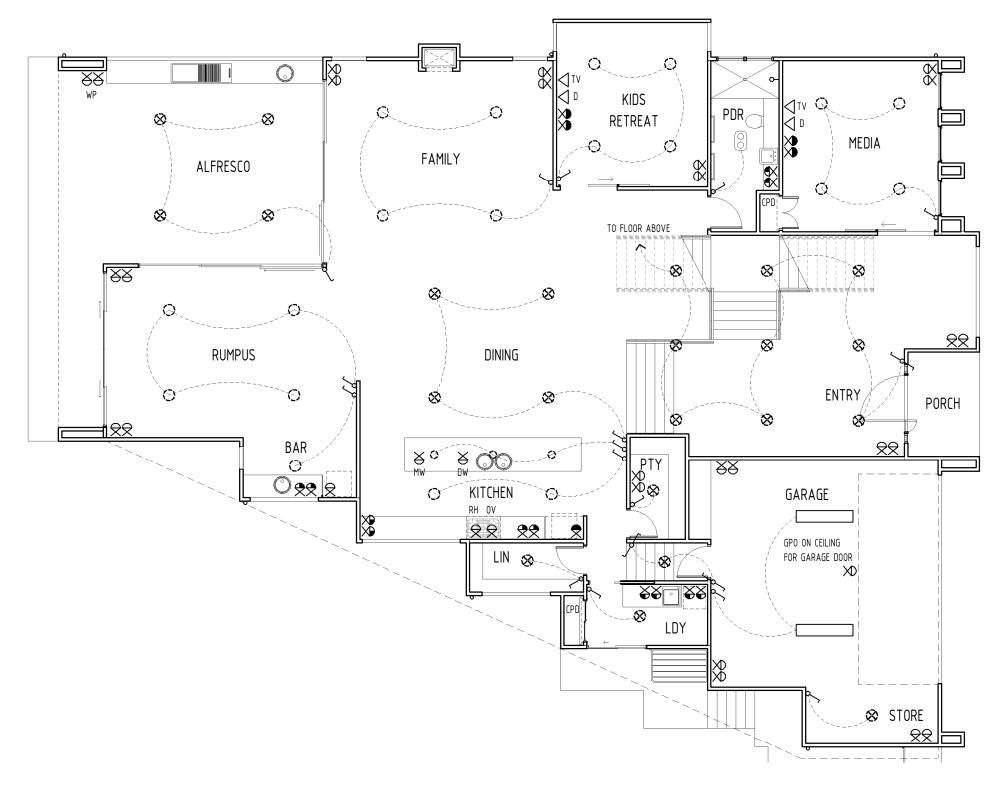


GROUND FLOOR- ELECTRICAL

SCALE 1: 100 @ A3





	PROJECT. PROPOSED RESIDENCE FOR		DRAWING TITLE. GROUND FLOOR - ELEI	CTRICAL	
Λ H Δ Λ	LOT ****, ****** QLD	***			
ARCHITECTURAL HOUSE DESIGNS AUSTRALIA	DESIGNED BY. DP	DRAWN BY. DP	DRAWING SCALE.	DRAWING NUMBER.	ISSUE.
	DATE. JANUARY 2016	PROJECT No. ****	1:100 @ A3	A208	Α

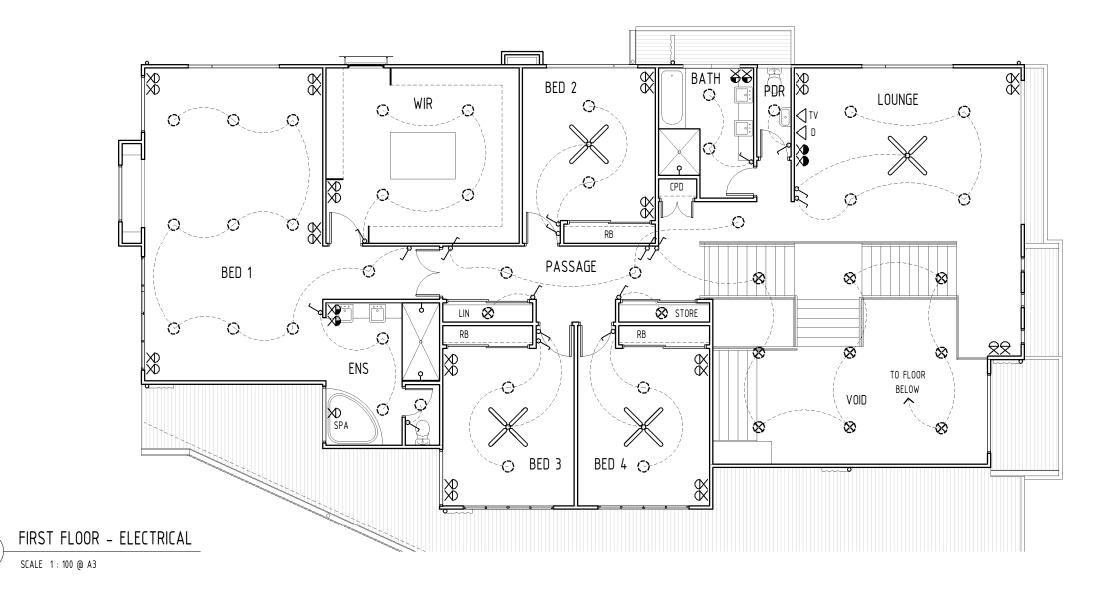

 \Re LIGHTING LEGEND d DIM LIGHT SWITCH WITH DIMMER HEATING LEGEND POWER LEGEND DOUBLE GPO - 300mm 1200 FLUORO - SINGLE 600 \oplus CEILING HEATING DUCT (APPROX LOCATION) SINGLE GPO - 300mm CEILING FAN 1200 FLUORO - DOUBLE DOUBLE GPO - 750mm \Re SINGLE GPO - 750mm DOUBLE GPO - 1100mm PENDANT LIGHT CEILING FAN WITH LIGHT WALL LIGHT BATTEN HOLDER HEATING UNIT WITH LIGHT & GPO IN CEILING ¬νζν− MΓ X ? WALL MOUNTED LIGHT \oplus SINGLE GPO - 1100mm DOUBLE GPO - 1500mm PARA FLOOD LIGHT - SINGLE DIMMER LIGHT SWITCH THERMOSTAT \otimes \bowtie $\overline{\mathbf{x}}$ EXTERNAL LIGHT POINT SENOR LIGHT - DOUBLE SECURITY SENSOR RA RETURN AIR SINGLE GPO - 1500mm SPP FOR R/HOOD AT 1800H [5] **→**S.D SMOKE DETECTOR 00 HEATER/FAN 7 LIGHT - 2 GLOBE 1200 FLUORO - DOUBLE CEILING EXHAUST FAN EVAPORATIVE COOLING DUCT SINGLE GPO - EXTERNAL **₹**WP CEILING EXHAUST FAN SWITCHED $\gtrsim_{ t DW}$ SINGLE GPO - D/WASHER @750H LIGHT SWITCH OYSTER LIGHT ACC - LOCATION TO BE CONFIRMED METER BOX / EARTHING WITH LIGHT \Re_{MW} \bigcirc D 2 WAY - LIGHT SWITCH JB JUNCTION BOX AC UNIT - LOCATION TO BE CONFIRMED SINGLE GPO - M/WAVE @750H 8 < ↑ SINGLE GPO - FOR SECURITY SYSTE TELEPHONE POINT

ELECTRICAL NOTE

ALL SYMBOLS AND SYMBOL LOCATIONS ARE INDICATIVE ONLY AND TO BE USED AS A GUIDE ONLY.

SYMBOLS AND LOCATIONS ARE NOT DRAWN TO SCALE.

BOTH POWER POINTS FOR THE UBI & COOKTOP SHOULD SIT TO THE RIGHT HAND SIDE OF THE OVEN.

10AMP GPO FOR UBO ON SEPARATE CIRCUIT @ 750H SPP FOR COOKTOP @ 750H SPP @ 1700H FOR RANGEHOOD

NOTE: LOCATIONS OF ALL ELECTRICAL AND LIGHTING TO BE CONFIRMED WITH CLIENT BEFORE CONSTRUCTION

ARCHITECTURAL HOUSE DESIGNS AUSTRALIA


A: 297 RIDING ROAD, BALMORAL QLD 4171

MB: 0423 303 011 QBSA: 1122353 ABN: 93158362031





	PROJECT.		DRAWING TITLE.		
	PROPOSED RESIDENCE FOR	*. & *. ****	FIRST FLOOR - ELECT	RICAL	
	LOT ****, ****** QLD	***			
	DESIGNED BY. DP	DRAWN BY. DP	DRAWING SCALE.	DRAWING NUMBER.	ISSUE.
l	DATE. JANUARY 2016	PROJECT No. ****	As indicated @ A3	A209	Α

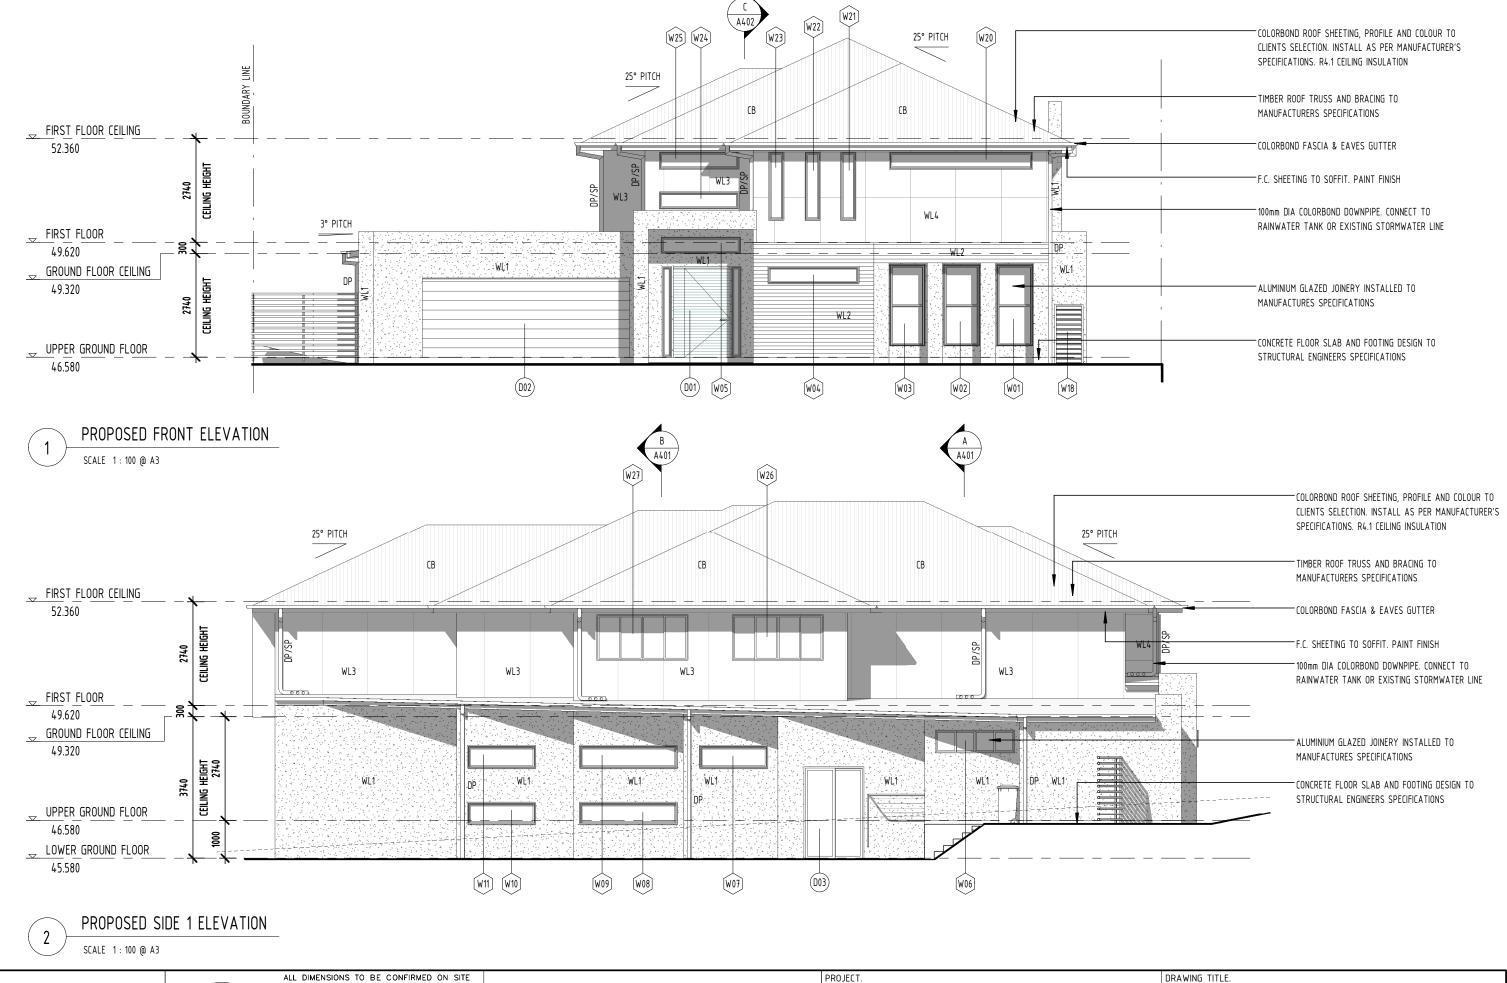

ARCHITECTURAL HOUSE DESIGNS AUSTRALIA

A: 297 RIDING ROAD, BALMORAL QLD 4171

MB: 0423 303 011

QBSA: 1122353 ABN: 93158362031

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PROPOSE

LOT ***

DESIGNED BY.

 PROJECT.
 DRAWING TITLE.

 PROPOSED RESIDENCE FOR *. & *. *****
 ELEVATIONS

 LOT ****, ****** QLD ***
 DP


 DESIGNED BY.
 DP

 DATE. JANUARY 2016
 PROJECT No. *****

 DATE. JANUARY 2016
 PROJECT No. *****


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 DRAWING NUMBER.


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ALL DIMENSIONS TO BE CONFIRMED ON SITE BEFORE ORDERING OR PREFABRICATING WORKS. CLARIFY ANY DISCREPANCIES BEFORE PROCEEDING. DO NOT SCALE FROM DRAWINGS. THESE DESIGNS AND PLANS ARE SUBJECT TO THE COPYRIGHT ACT OF 1968 AND THE COPYRIGHT AMENDMENT (MORAL RIGHTS) BILL 1999 AND ARE NOT TO BE USED OR REPRODUCED WITHOUT THE WRITTEN CONSENT OF THE PROPRIETOR. DP DP A: 297 RIDING ROAD, BALMORAL QLD 4171 DATE. JANUARY 2016 MB: 0423 303 011 **** 1:100 @ A3 A302 QBSA: 1122353 ABN: 93158362031
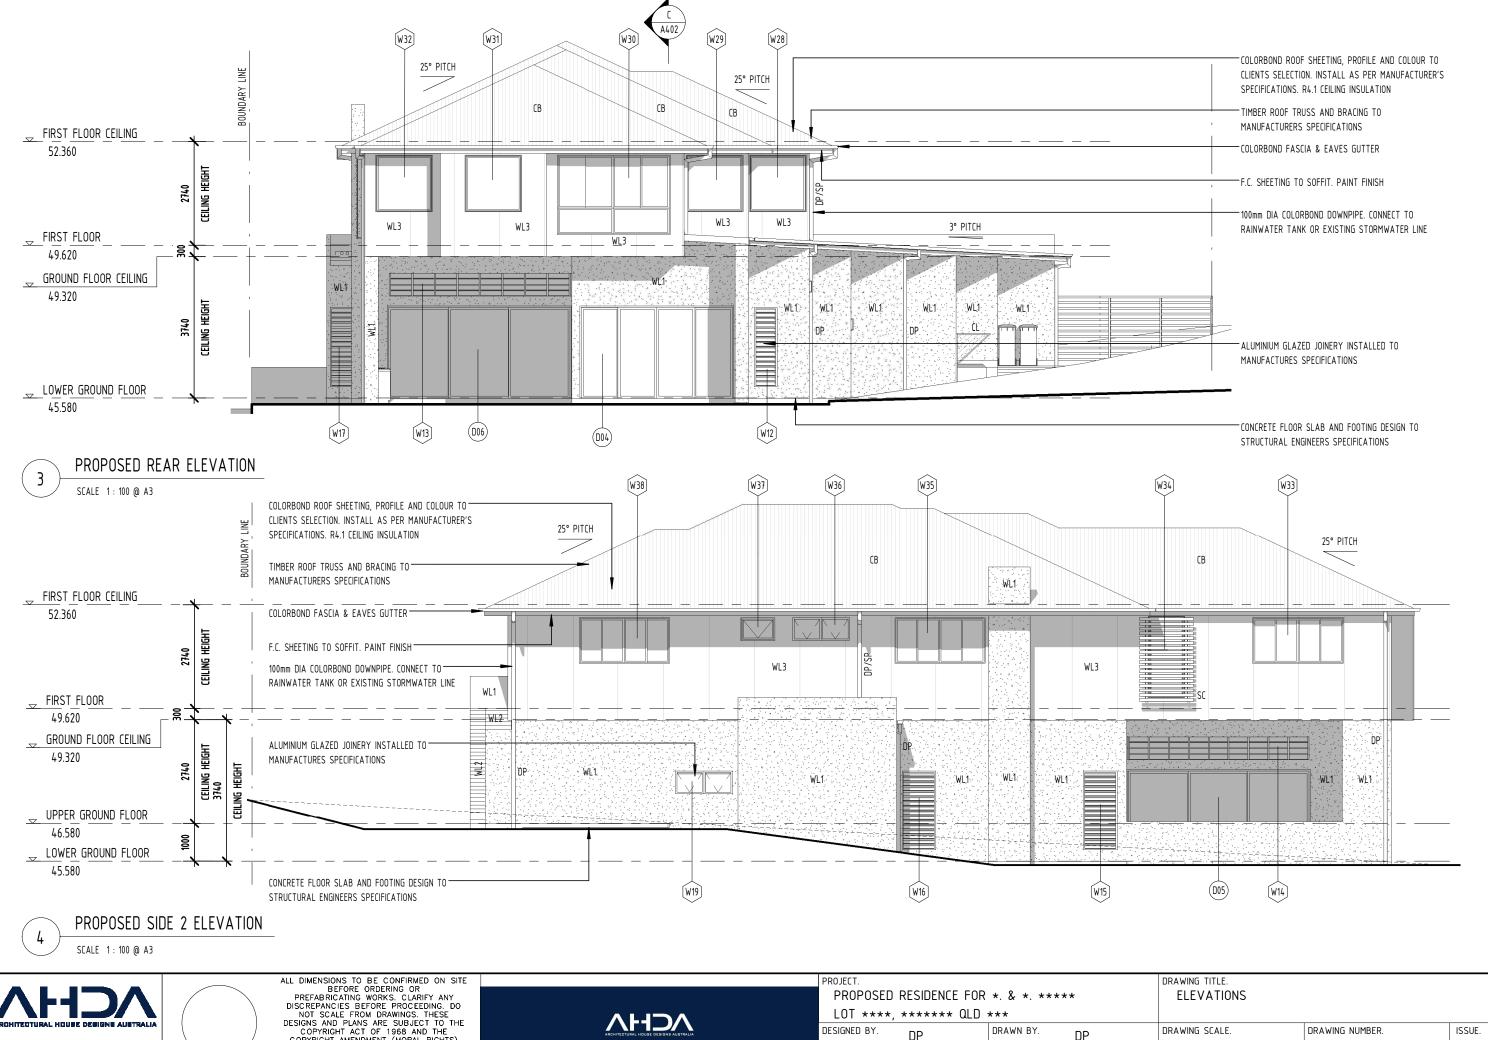
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GENERAL NOTES

1. PLANS ATTACHED ARE TO BE READ INCONJUNCTION WITH CODE & MANUFACTURERS INFORMATION TO OBTAIN ADDITIONAL INFORMATION TO CORRECTLY CONSTRUCT THIS PROJECT TO COMPLY WITH ALL CURRENT CODES & BUILDING REQUIREMENTS & IT WILL BE ASSUMED THE BUILDER WILL HAVE THESE DOCUMENTS AS REFERENCE MATERIALS. 2. ALL CONSTRUCTION WORK, MATERIALS, AND FIXING METHODS FOR EACH TRADE/PRODUCT IS TO COMPLY WITH THE RELEVANT "AUSTRALIAN STANDARD" AS PUBLISHED BY THE "STANDARDS ASSOCIATION OF AUSTRALIA" & MATERIALS SUPPLIED TO HAVE MANUFACTURES DATA APPROVAL "PRODUCT REGISTRATION" PURSUANT TO SECTION 13 OF THE STANDARD BUILDING BY-LAWS.

3. ALL CONSTRUCTION METHODS AND MATERIALS
TO BE IN ACCORDANCE WITH - "THE BUILDING
CODE OF AUSTRALIA" AND ALL OTHER RELEVANT
DOCUMENTS.

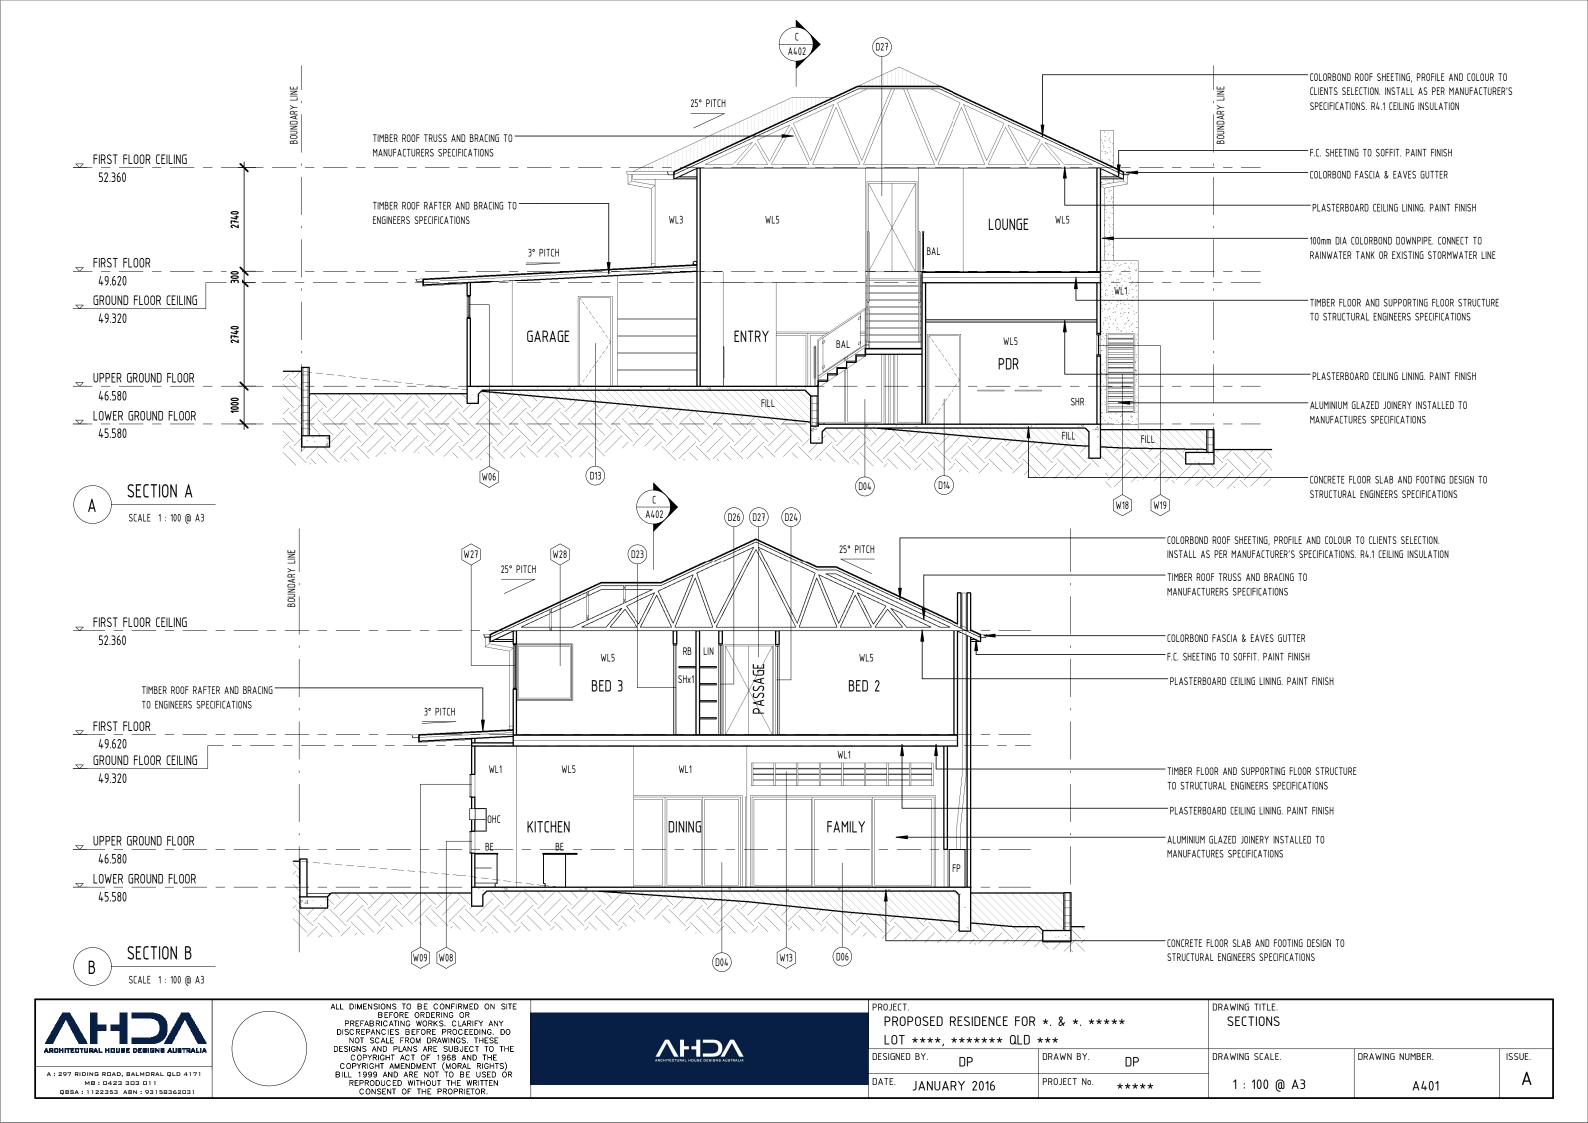ELEVATION / SECTION LEGEND

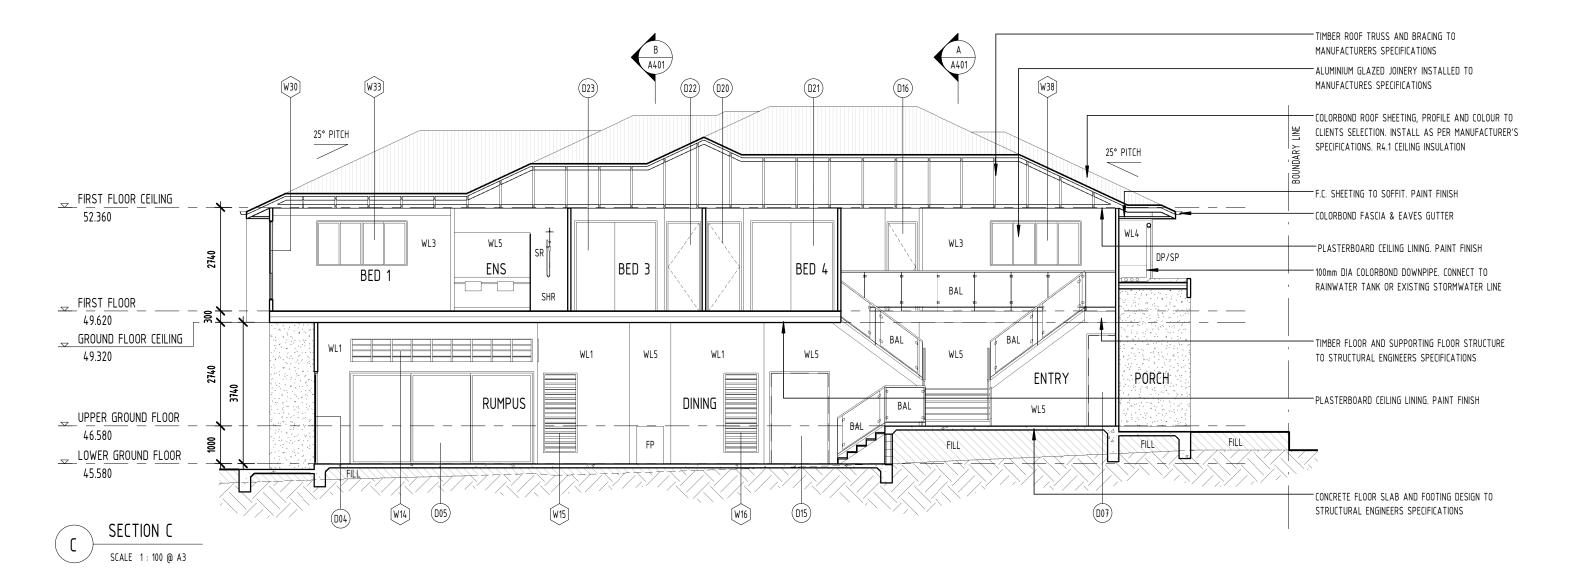- CB COLORBOND ROOF SHEETING
- CL CLOTHES LINE
- DP 100mm DIA COLORBOND DOWNPIPE. CONNECT TO RAINWATER TANK OR EXISTING STORMWATER LINE
- DOOR NUMBER, REFER TO SCHEDULE
- W00 WINDOW NUMBER, REFER TO SCHEDULE
- WL1 90mm TIMBER STUD WALL WITH FC
 SHEETING TO EXTERIOR, RENDERED
 FINISH. PLASTERBOARD TO INTERIOR,
 PAINT FINISH. AQUACHEK TO WET
 AREAS. R2.8 WALL INSULATION
- WL2 90mm TIMBER STUD WALL WITH
 WEATHERBOARDS TO EXTERIOR, PAINT
 FINISH. PLASTERBOARD TO INTERIOR,
 PAINT FINISH. AQUACHEK TO WET
 AREAS. R2.8 WALL INSULATION
- 70mm TIMBER STUD WALL WITH FC SHEETING WITH EXPOSED BATTENS TO EXTERIOR, PAINT FINISH. PLASTERBOARD TO INTERIOR, PAINT FINISH. AQUACHEK TO WET AREAS. R2.8 WALL INSULATION
- 90mm TIMBER STUD WALL WITH MATRIX CLADDING TO EXTERIOR, PAINT FINISH. PLASTERBOARD TO INTERIOR, PAINT FINISH. AQUACHEK TO WET AREAS. R2.8 WALL INSULATION



MB: 0423 303 011 QBSA:1122353 ABN:93158362031





PROJECT.		DRAWING TITLE.		
PROPOSED RESIDENCE FOR	*. & *. ****	SECTION		
LOT ****, ****** QLD	***			
DESIGNED BY. DP	DRAWN BY. DP	DRAWING SCALE.	DRAWING NUMBER.	ISSUE.
DATE. JANUARY 2016	PROJECT No. ****	1:100 @ A3	A402	Α

DOOR SCHEDULE **FRAME NUMBER LEVEL** HEIGHT WIDTH **FINISH MATERIAL** COMMENTS UPPER GROUND FLOOR 2400 CLEAR ALUMINIUM PIVOT DOOR, GLAZED SOLID-CORE, EXTERNAL GRADE, HINGED DOOR D02 UPPER GROUND FLOOR 2100 5500 COLORBOND AUTOMATIC, PANEL LIFT, GARAGE DOOR STEEL D03 LOWER GROUND FLOOR 2400 1500 CLEAR ALUMINIUM GLASS SLIDING DOOR, (OX) D04 LOWER GROUND FLOOR 2400 4000 CLEAR ALUMINIUM GLASS SLIDING DOOR, (OXXO) D05 UPPER GROUND FLOOR 2400 4800 CLEAR ALUMINIUM GLASS SLIDING DOOR, (XXO) D06 LOWER GROUND FLOOR 2400 4800 CLEAR **ALUMINIUM** GLASS SLIDING DOOR, (OXX) D07 UPPER GROUND FLOOR 2400 1500 PAINT **TIMBER** HOLLOW-CORE, FLUSH PANEL, FACE MOUNTED SLIDING DOOR D08 UPPER GROUND FLOOR 2040 840 PAINT **TIMBER** 2 x 420, HOLLOW-CORE, FLUSH PANEL, HINGED DOOR D09 LOWER GROUND FLOOR 2340 720 PAINT TIMBER HOLLOW-CORE, FLUSH PANEL, HINGED DOOR D10 LOWER GROUND FLOOR 720 PAINT TIMBER HOLLOW-CORE, FLUSH PANEL, HINGED DOOR 2340 D11 LOWER GROUND FLOOR 2340 820 PAINT **TIMBER** HOLLOW-CORE, FLUSH PANEL, CAVITY SLIDER DOOR D12 LOWER GROUND FLOOR 2400 1100 VINYL ALUMINIUM WARDROBE SLIDING DOORS D13 2340 820 UPPER GROUND FLOOR PAINT TIMBER HOLLOW-CORE, FLUSH PANEL, HINGED DOOR D14 LOWER GROUND FLOOR 2340 820 PAINT TIMBER HOLLOW-CORE, FLUSH PANEL, HINGED DOOR D15 LOWER GROUND FLOOR 2400 1500 PAINT **TIMBER** HOLLOW-CORE, FLUSH PANEL, FACE MOUNTED SLIDING DOOR D16 FIRST FLOOR 2340 720 PAINT **TIMBER** HOLLOW-CORE, FLUSH PANEL, HINGED DOOR D17 FIRST FLOOR 2340 720 PAINT **TIMBER** HOLLOW-CORE, FLUSH PANEL, HINGED DOOR D18 FIRST FLOOR 2040 840 PAINT TIMBER 2 x 420, HOLLOW-CORE, FLUSH PANEL, HINGED DOOR D19 FIRST FLOOR 2400 2000 ALUMINIUM VINYL WARDROBE SLIDING DOORS D20 FIRST FLOOR 2340 820 PAINT TIMBER HOLLOW-CORE, FLUSH PANEL, HINGED DOOR D21 FIRST FLOOR 2400 2200 MIRROR / VINYL ALUMINIUM WARDROBE SLIDING DOORS D22 FIRST FLOOR 2340 820 PAINT TIMBER HOLLOW-CORE, FLUSH PANEL, HINGED DOOR D23 FIRST FLOOR 2400 2200 MIRROR / VINYL ALUMINIUM WARDROBE SLIDING DOORS D24 FIRST FLOOR TIMBER 2340 820 PAINT HOLLOW-CORE, FLUSH PANEL, HINGED DOOR D25 MIRROR / VINYL FIRST FLOOR 2400 2200 **ALUMINIUM** WARDROBE SLIDING DOORS D26 FIRST FLOOR 2400 2200 VINYL **ALUMINIUM** WARDROBE SLIDING DOORS D27 FIRST FLOOR 2340 1240 PAINT **TIMBER** 2 x 620, HOLLOW-CORE, FLUSH PANEL, HINGED DOOR D28 FIRST FLOOR 2340 820 PAINT **TIMBER** HOLLOW-CORE, FLUSH PANEL, HINGED DOOR D29 2340 720 WARDROBE SLIDING DOORS FIRST FLOOR PAINT TIMBER


Grand total: 29

DOOR / WINDOW LEGEND

DESIGNED IN ACCORDANCE WITH BCA

- FLASHING TO WALL OPENINGS 3.5.3.6
- GLAZING & WINDOW ASSEMBLIES 3.6.0

BUILDER TO CONFIRM SIZES ON SITE BEFORE ORDERING DOORS & WINDOWS

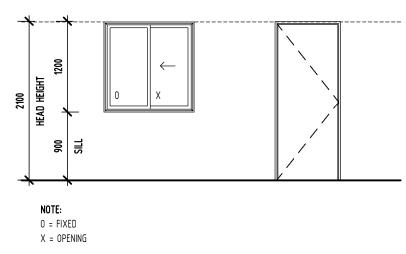

ARCHITECTURAL HOUSE DESIGNE AUSTRALIA

A: 297 RIDING ROAD, BALMORAL QLD 4171 MB: 0423 303 011 QBSA: 1122353 ABN: 93158362031





PROJECT.		DRAWING TITLE.		
PROPOSED RESIDENCE FOR	*. & *. ****	DOOR SCHEDULE		
LOT ****, ****** QLD	***			
DESIGNED BY. DP	DRAWN BY. DP	DRAWING SCALE.	DRAWING NUMBER.	ISSUE.
DATE. JANUARY 2016	PROJECT No. ****	1:50 @ A3	A501	Α


WINDOW SCHEDULE										
NUMBER	11	WINDOW	LIEICLIT	VADTU	FRAMING	CL A ZINIC	SILL			
NUMBER Level	Level	STYLE	HEIGHT	WIDTH	MATERIAL	GLAZING	HEIGHT			
W01	UPPER GROUND FLOOR	DOUBLE HUNG	2100	900	ALUMINIUM	CLEAR	300			
W02	UPPER GROUND FLOOR	DOUBLE HUNG	2100	900	ALUMINIUM	CLEAR	300			
W03	UPPER GROUND FLOOR	DOUBLE HUNG	2100	900	ALUMINIUM	CLEAR	300			
W04	UPPER GROUND FLOOR	FIXED	450	2400	ALUMINIUM	CLEAR	1950			
W05	UPPER GROUND FLOOR	FIXED	450	2100	ALUMINIUM	CLEAR	2750			
W06	UPPER GROUND FLOOR	SLIDING (OXXO)	600	2100	ALUMINIUM	CLEAR	1800			
W07	LOWER GROUND FLOOR	FIXED	600	1800	ALUMINIUM	CLEAR	2400			
W08	LOWER GROUND FLOOR	FIXED	600	2600	ALUMINIUM	CLEAR	900			
W09	LOWER GROUND FLOOR	FIXED	600	2600	ALUMINIUM	CLEAR	2400			
W10	UPPER GROUND FLOOR	FIXED	600	1800	ALUMINIUM	CLEAR	-100			
W11	LOWER GROUND FLOOR	FIXED	600	1800	ALUMINIUM	CLEAR	2400			
W12	LOWER GROUND FLOOR	LOUVRE	2100	600	ALUMINIUM	CLEAR	300			
W13	LOWER GROUND FLOOR	LOUVRE	600	4800	ALUMINIUM	CLEAR	2700			
W14	LOWER GROUND FLOOR	LOUVRE	600	4800	ALUMINIUM	CLEAR	2700			
W15	LOWER GROUND FLOOR	LOUVRE	2100	900	ALUMINIUM	CLEAR	300			
W16	LOWER GROUND FLOOR	LOUVRE	2100	900	ALUMINIUM	CLEAR	300			
W17	LOWER GROUND FLOOR	LOUVRE	2100	750	ALUMINIUM	CLEAR	300			
W18	LOWER GROUND FLOOR	LOUVRE	2100	750	ALUMINIUM	CLEAR	300			
W19	LOWER GROUND FLOOR	AWNING	600	1500	ALUMINIUM	OPAQUE	1800			
W20	FIRST FLOOR	FIXED	450	3800	ALUMINIUM	CLEAR	1950			
W21	FIRST FLOOR	FIXED	1800	400	ALUMINIUM	CLEAR	600			
W22	FIRST FLOOR	FIXED	1800	400	ALUMINIUM	CLEAR	600			
W23	FIRST FLOOR	FIXED	1800	400	ALUMINIUM	CLEAR	600			
W24	FIRST FLOOR	FIXED	450	2100	ALUMINIUM	CLEAR	900			
W25	FIRST FLOOR	FIXED	450	2100	ALUMINIUM	CLEAR	1950			
W26	FIRST FLOOR	SLIDING (OXXO)	1200	2400	ALUMINIUM	CLEAR	1200			
W27	FIRST FLOOR	SLIDING (OXXO)	1200	2400	ALUMINIUM	CLEAR	1200			
W28	FIRST FLOOR	FIXED	1500	1500	ALUMINIUM	CLEAR	900			
W29	FIRST FLOOR	FIXED	1500	1500	ALUMINIUM	OPAQUE	900			
W30	FIRST FLOOR	SLIDING (OXXO)	2100	3000	ALUMINIUM	CLEAR	300			
W31	FIRST FLOOR	FIXED	1500	1500	ALUMINIUM	CLEAR	900			
W32	FIRST FLOOR	FIXED	1500	1500	ALUMINIUM	CLEAR	900			
W33	FIRST FLOOR	SLIDING (OXXO)	1200	2400	ALUMINIUM	CLEAR	1200			
W34	FIRST FLOOR	DOUBLE HUNG	2100	900	ALUMINIUM	CLEAR	300			
W35	FIRST FLOOR	SLIDING (OXXO)	1200	2400	ALUMINIUM	CLEAR	1200			
W36	FIRST FLOOR	AWNING	600	1500	ALUMINIUM	OPAQUE	1800			
W37	FIRST FLOOR	AWNING	600	900	ALUMINIUM	OPAQUE	1800			
W38	FIRST FLOOR	SLIDING (OXXO)	1200	2400	ALUMINIUM	CLEAR	1200			

DOOR / WINDOW LEGEND

DESIGNED IN ACCORDANCE WITH BCA

- FLASHING TO WALL OPENINGS 3.5.3.6
- GLAZING & WINDOW ASSEMBLIES 3.6.0

BUILDER TO CONFIRM SIZES ON SITE BEFORE ORDERING DOORS & WINDOWS

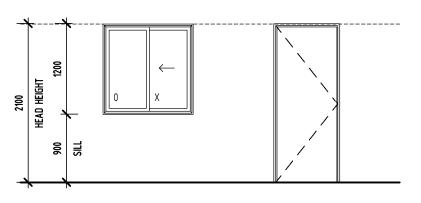

ISSUE.


Α

NOTE:0 = FIXED

0 = FIXED X = OPENING





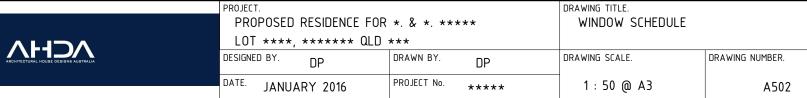



3D PERSPECTIVE 3

SCALE @ A3




3D PERSPECTIVE 5

SCALE @ A3



3D PERSPECTIVE 4

SCALE @ A3

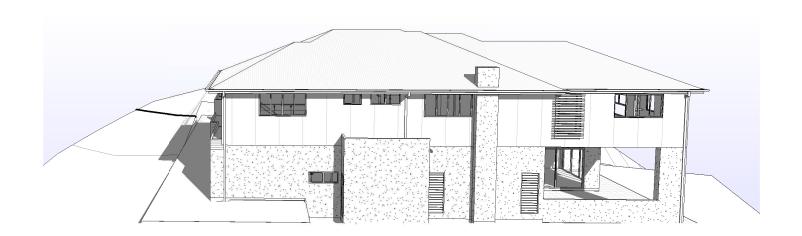

3D PERSPECTIVE 6

SCALE @ A3





